

### THE HONG KONG HOUSING AUTHORITY

## Memorandum for Building Committee

Proposed Master Layout Plan, Scheme Design & Project Development Budget for Public Rental Housing Development at Shatin Area 2B (Hin Wo Lane)

### **PURPOSE**

To seek Members' approval to the proposed Master Layout Plan, Scheme Design and Project Development Budget for the Public Rental Housing Development at Shatin Area 2B (Hin Wo Lane).

### BACKGROUND

- 2. Shatin Area 2B was previously reserved for the development of a polyclinic and a general clinic. To meet CE's pledge of 85,000 flats per year, the development was identified as one of HOUSCOM's control projects to boost housing supply in the year 2003/04.
- 3. The whole of Area 2B is carved out into two separate portions, the major portion for the construction of housing and the remaining portion for clinic building.
- 4. The housing portion with a gross site area of about 0.573 ha, is rezoned from "Government, Institution and Community" (GIC) to Residential (A). The Draft Outline Zoning Plan (OZP No. S/ST/13) was gazetted on 8 October 1999.
- 5. The Strategic Planning Committee (SPC) has, at its meeting held on 11.9.99, approved the inclusion of this site in the Public Housing Development Programme (PHDP) and the Project Development Cost Ceiling.

6. Past events which are relevant to this project are as follows –

	Date	Event	
(a)	21.5.1999	Client Brief, Control Plan and Project Estimate endorsed by the department's Project Design Review Committee (PDRC Paper No. 28/99)	
(b)	29.6.1999	Shatin District Board Consultation	
(c)	11.9.1999	Inclusion into Public Housing Development Programme (PHDP) approved by Strategic Planning Committee (SPC) of Paper No. SPC 30/99	
(d)	11.2.2000	DipCon Submission for the agreement on the planning parameters was endorsed	
(e)	2.3.2000	Endorsed by Project Design Review Committee for submission to the Building Committee (Paper No. PDRC 4/00 refers)	

### SCHEME DESIGN PROPOSAL

- 7. The proposed Master Layout Plan and Scheme Design at Part I and Part II of the attached Annex generally follows the development parameters and the conceptual layout endorsed in above 6(c). Explanatory notes and drawings attached as Part I and Part II of the Annex illustrate the disposition of the housing block, vehicular and pedestrian access and other facilities.
- 8. The proposed development comprises of
  - (a) 1 no. 41- storey New Harmony 1 Option 6 Block on grade;
  - (b) 50 nos. covered private car parking spaces & 8 nos. light goods vehicle parking spaces;

- (c) 1 no. Estate Management Office (EMO);
- (d) 1 no. Refuse Collection Point (RCP);
- (e) Associated external works.
- 9. The main features of the design are as follows
  - (a) To mitigate noise generated from surrounding traffic,
    - A maximum domestic setback of 14m from Che Kung Miu Road and 40m from Tin Sam Street are provided.
    - Provision of noise barriers 10 m high to the west of the site and 7m high on top of roof of carpark to the north.
  - (b) Architectural treatment to the Noise Barrier is as follows =
    - The high noise barriers are the dominant features to the development at street level. Care has been taken to avoid adverse visual impact.
    - The overhanging canopy at the top of the noise barrier is repeated at the roof level of the domestic block to unify the appearance of the whole development and provide specific individual identity.
  - (c) An 8.5m wide drainage reserve area along site boundary to the south is required to be free from permanent structures.
  - (d) EPD required for air-conditioning to the noise affected units on late March 2000, which is not in line with the established policy. Project team will liaise with EPD and develop further architectural details to mitigate the noise issue.

## PROPOSED PROJECT DEVELOPMENT BUDGET

- 10. Based on the proposed Master Layout Plan and Scheme Design, the Project Development Budget for the development is estimated to be \$372.629 M.
- 11. The breakdown of the budget is given in Part IV of the Annex and the key elements are as follows –

		Aspect	Project Development Budget (\$M)
(a)	Site Development	Cost	-
(b)	Construction Cost	Foundation	27.260
		Building	263.827
		Soft Landscape & Others	0.942
		Sub-total (b)	292.029
(c)	Project Manageme (a + b) x 14%	nt Cost	40.884
(d)	Other Project Cost (a + b) x 2%		5.841
(e)	(e) Development Contingency (a+b+c+d) x 10%		33.875
	al Project developm + (b) + (c) + (d) + (		372.629

12. The Unit Cost of the Proposed Project Development Budget as compared with SPC's Approved Project Development Unit Cost Ceiling is as follows –

	(a)	(b)	(c)	(d)
	Unit Cost of	SPC's	Overall Unit	June 1999
	Proposed	approved	Cost of	Cost
	Project	project	Construction	Yardsticks
	Development	development	included in (a)	adjusted to
	Budget	unit cost	(excluding	tender-in-
		ceiling (SPC Paper	external works and others)	date
		No. 30/99)		
	(\$ / m <sup>2</sup> CFA)	(\$ / m <sup>2</sup> CFA)	(\$ / m <sup>2</sup> CFA)	(\$ / m <sup>2</sup> CFA)
Domestic (PRH)	9,959	10,812	6,281	6,931
Private Carpark	5,698	6,763	3,055	4,324
LGV	1,419	1,506	1,112	1,109

- 13. The proposed Unit Development Cost Budget is within the SPC's Approved Unit Development Cost Ceiling.
- 14. The difference between the Overall Unit Cost of Construction (excluding external works and others) and the June 1999 Cost Yardsticks adjusted to Tender-In-Date are attributable to the following:
  - (a) Adjustment for foundations to domestic block.
  - (b) Additional allowance for single block project.

15. The proposed Project Development Cost for the public rental housing portion can be broken down into the cost per flat as follows:

Flat	(a)	(b)	(c)
Туре	Proposed	Overall Construction Cost	June 1999 Cost
	Development	per Flat included in (a)	Yardstick Adjusted
	Cost per flat	(excluding External Works	to Tender-in-Date
	-	& Others)	(per flat)
	(\$)	(\$)	(\$)
1P/2P	\$301,758	\$190,314	\$181,255
2P/3P	\$389,397	\$245,587	\$233,392
1B	\$516,872	\$325,984	\$309,989
2B	\$679,204	\$428,364	\$407,352

## **AVAILABILITY OF FUNDS**

16. The estimated yearly expenditure of the Proposed Budget is shown below and would be included in the next capital budget updating of the Authority –

		Estimated Expenditure (\$M)		
	2000/2001	2001/2002	Post 31.3.2001	Total
Estimate	17.400	92.270	262.959	372.629

17. Provision in the Housing Authority's Capital Budget for the year 2000/2001 is \$31.650M (Paper No. FC 2/2000).

## DEVELOPMENT PROGRAMME

18. Details of the Development Programme are in Part III of the Annex. The key dates are –

		Event	Date
(a)	Scheme Design	PDRC(2)	2/3/00
(b)	Design & Budget	ВС	4/00
(c)	Detailed Design	DDRP	6/00
(d)	Piling	Commencement Completion	10/00 8/01
(e)	Building	Commencement Completion	8/01 2/04

## RECOMMENDATIONS

19. It is recommended that the proposed Master Layout Plan, Scheme Design and Project Development Budget for the proposed Public Rental Housing Development at Shatin Area 2B be approved.

## **DISCUSSION**


20. At the next meeting of the Building Committee to be held on 27 April 2000, Members will be invited to approve the recommendation in paragraph 19 above.

File Ref.: HD(AR) 1/55/693/1

Date : 26 April 2000

# PUBLIC RENTAL HOUSING DEVELOPMENT AT SHATIN AREA 2B

PROPOSED MASTER LAYOUT PLAN, SCHEME DESIGN & PROJECT DEVELOPMENT BUDGET

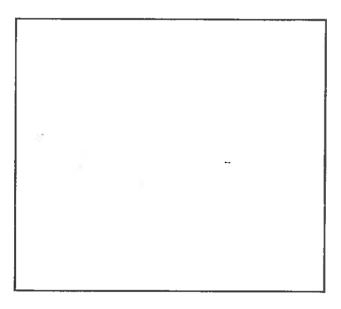

**BC SUBMISSION, APRIL 2000** 



DEVELOPMENT AND CONSTRUCTION BRANCH HOUSING DEPARTMENT

#### **Amendment Record Sheet**

### Part I: Master Layout Plan

#### 1. Introduction

- 1.1 Background
- 1.2 Location Plan

## 2. Site Analysis & Evaluation

- 2.1 Planning and Land Matters
  - 2.1.1 Site Location
  - 2.1.2 Adjacent Land Uses
  - 2.1.3 Zoning Consideration
  - 2.1.4 Land Clearance / Resumption
  - 2.1.5 Height Restriction
- 2.2 Engineering Considerations
  - 2.2.1 Noise and Air
  - 2.2.2 Geotechnical Consideration
  - 2.2.3 Foundation Design
  - 2.2.4 Drainage and Sewerage
  - 2.2.5 Water Supply
  - 2.2.6 Electricity, Telephone, Gas
  - 2.2.7 Traffic Improvement
  - 2.2.8 Drainage Reserve Area
  - 2.2.9 Site Formation

### 3. Accommodation and Facilities

- 3.1 Site Area
- 3.2 Development Ratio
- 3.3 Flat Number and Flat Mix
- 3.4 Design Population 3.5 Refuse Collection Point
- 3.6 Management Accommodation
  - 3.6.1 Estate Management Office
  - 3.6.2 MAC Office
  - 3.6.3 Artisan Workshop
  - 3.6.4 Office for Cleansing Contr.
  - 3.6.5 BW Term Maintenance Contr. Service / Store Room
  - 3.6.6 BS Term Maintenance Contr. Service / Store Room
- 3.7 Open Space
  - 3.7.1 Local Open Space
  - 3.7.2 recreation Facilities

# 4. Circulation and Transportation Matters

- 4.1 Vehicular Access
- 4.2 Pedestrian Access
- 4.3 Control of Ingress / Egress
- 4.4 Emergency Vehicular Access
- 4.5 Pedestrian Network
- 4.6 Parking Provision
  - 4.6.1 Carpark Spaces
  - 4.6.2 Motor-cycle Spaces
  - 4.6.3 Light Goods Vehicle Spaces
  - 4.6.5 Residential Loading/ Unloading
  - 4.6.6 Bicycle Parking

#### 5. Design Consideration

- 5.1 Block Types, Disposition & Orientation
- 5.2 Noise Barrier Design
- 5.3 Landscape Design
- 5.4 Design For the Disabled
- 5.5 Graphics and Signage

### Part II: Master Layout Drawings

## Part III: Development Programme

### Part IV: Project Development Budget

# AMENDMENT RECORD SHEET

_					
		1	TE OF	ISSU	E
	MONTH	04			
	YEAR	00			
		ISS	TE NI	J <b>MBE</b> I	R
					-
Co	ntent	1			
Am	endment Record Sheet	1			
	t I: Master Layout Plan				
1.	Introduction				
	1.1 Background	1			
	1.2 Location Plan	1			
2.	Site Analysis & Bushastian				
4.	Site Analysis & Evaluation 2.1 Planning and Land Matters	.			
		1			
	2.2 Engineering Considerations	1			
3.	Accommodation and Facilities			Ī	
	3.1 Site Area	١,			
	3.2 Development Ratio	1 1	l	I	
	3.3 Flat Number and Flat Mix	1 1		Į	
	3.4 Design Population	1			
	3.5 Refuse Collection Point	1			
	3.6 Management Accommodation	1	ļ ļ	I	
	3.7 Open Space	Ī		Ì	
	on open space	1		i	
4.	Circulation and Transportation Matters			1	
	4.1 Vehicular Access	1		ì	
	4.2 Pedestrian Access	i	]		
	4.3 Control of Ingress / Egress	i			
	4.4 Emergency Vehicular Access	î			
	4.5 Pedestrian Network	i		ı	
	4.6 Parking Provision	i		Ī	
_					35
5.	Design Consideration			l	
	5.1 Block Types, Disposition & Orientation	1			
	5.2 Noise Barrier Design	1		i	
	5.3 Landscape Design	1		į	
	5.4 Design For Disabled	1			
	5.5 Graphic and Signage	1	1	4	
Dor	t II: Master Layout Drawings	_			
<u>rai</u>	t II . Master Layout Drawings	1			
Par	t III : Development Programme	1			
3	A STATE OF THE STA	1		i	
<u>Par</u>	t IV : Development Cost Budget	1			
Тh	is document has been reviewed and approved for adequacy				
111	is document has been reviewed and approved for adequacy				
	12/2011			1	
	11 Calloway			İ	
	GNED: Mr. I.A. GALLOWAY CA/2 (Atg.)			I	
D	ATE: 25 April 2000		į	\$ 5	
		ii	į	1	

SHATIN AREA 2 B BC - ISSUE 1


## INTRODUCTION

1.

### 1.1 BACKGROUND

- 1. The site is bounded by Che Kung Miu Road to the north and Tin Sam Street to the east. To its immediate west is a primary school located within Hin Keng Estate and south is an array of GIC facilities including a neighbourhood community centre, Tim Sum Divisional Police Station and Fire station. The site has a gross area of approx. 0.78 ha.
- 2. Originally, the site was reserved for the development of polyclinic and general clinic only. In view of the projected territory-wide shortfall of housing supply in the period 2001–2006, the Government identified the reserve clinic site in Area 2B as one of HOUSCOM's Control List for completion in 2003/04. As a result, a joint development proposal incorporating public housing of not less than 600 flats and the clinic will be planned, constructed and funded by HD and Health D respectively.
- 3. The subject site is originally zoned as GI/C and re-zoning of the housign portion to Residential (A) was incorporated into the Shatin OZP No. S/ST/13 which was gazetted on 8.10.1999 and no objection was received.
- 4. At present, the north-western portion of the site is occupied by Water Services Department under a short-term tenancy as a temporary maintenance yard. The southern portion is used as a temporary carpark. Upon DLO/ST's advice, the entire site can be ready for hand-over to HD and the Health Department for works commencement in October 2000.
- 5. The approval status of this PRHD scheme is as follows:
  - a) the development parameters, conceptual layout plans and cost estimates had been endorsed with revision on 21.5.1999 (PDRC Paper No. 28/99 refers).
  - b) the development parameters, conceptual layout plans and cost estimates were subsequently approved by Strategic Planning Committee (SPC) on 11.9.1999 (SPC Paper No. 30/99 refers) for inclusion into the Public Housing Development Programme (PHDP).
  - c) the planning parameters have been submitted for DIPCON circulation on September 1999 and was endorsed on 11.2.2000.
  - d) On 2.3.2000, the Proposed Master Layout Plan and the Project Development Cost Budget was endorsed by the Project Design Review Committee (Paper No. PDRC 4/00 refers)

## 1. INTRODUCTION

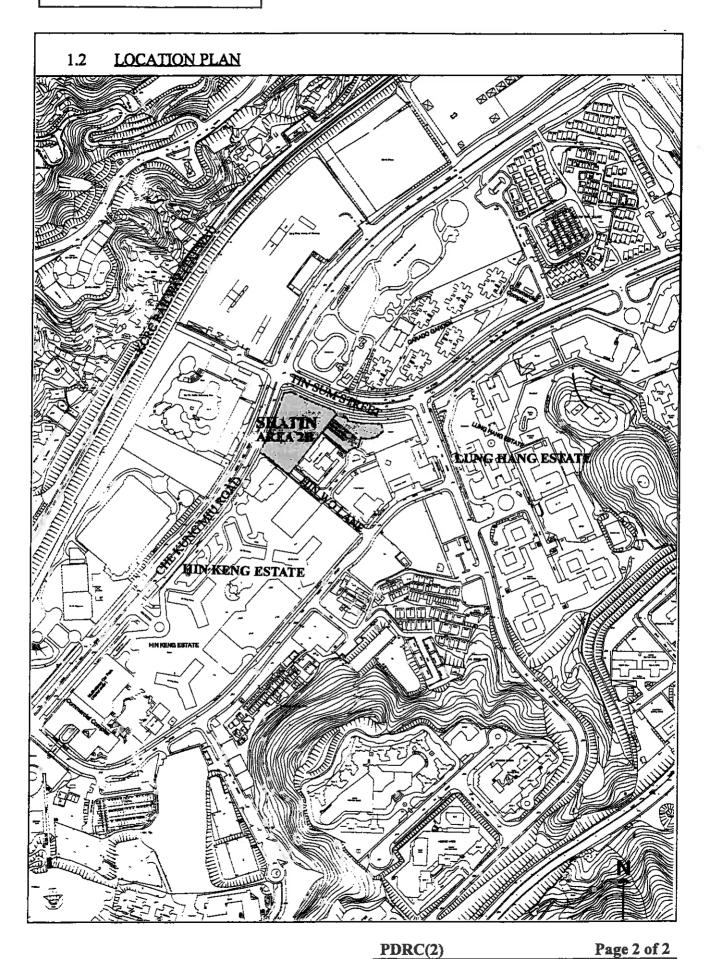

PART I - MASTER LAYOUT PLAN

#### 2. SITE ANALYSIS & EVALUATION

C

Proposed Master Layout Plan	Remarks
	The site is relatively flat with no slope in the adjoining areas.
As in the Approved Development Parameters.	
As in the Approved Development Parameters.	Z.
As in the Approved Development Parameters.	
According to the Final Road Traffic Noise Assessment by HD's consultant, Messrs. Ove Arup & Partners (ARUP) submitted to EPD on 28.2.2000, vertical noise barriers will be provided:	Draft final reports were submitted to EPD for comment since November 1999. EPD commented that additional measures such as cantilevered barrier along Che Kung Miu Road was desirable to explore on
	As in the Approved Development Parameters.  As in the Approved Development Parameters.  As in the Approved Development Parameters.  According to the Final Road Traffic Noise Assessment by HD's consultant, Messrs. Ove Arup & Partners (ARUP) submitted to EPD on

BC - ISSUE 1 Page 1 of 3

## 2. SITE ANALYSIS & EVALUATION

Approved Development Parameters	Proposed Master Layout Plan	Remarks
	carport facing Tin Sum Street, and 10m high along western boundary facing Che Kung Miu Road.  - Residual noise impacts will be mitigated by the provision of upgraded 6mm thick glass pane windows for the affected flats, with noise levels in excess of 70dB(A).	cantilevered canopies were provided.  The final report was submitted to EPD on 23.2.2000 and EPD's memo dated 21.3.2000 required air-conditioning to the noise affected flats (i.e.300 out of 799 flats) was stated.  A domestic set back of 14m from Che Kung Miu Road and 40m from Tin Sum Street are provided, and project team will liaise with EPD and develop further architectural details to mitigate the noise issue.
	**	A feature wall to be designed with solid and transparent screens to be provided for best noise screening as well as aesthetic results. (pls. refer to dwg no. SK/A/PLO-01)
2.2.2 Geotechnical Considerations No specific requirement.	The geological strata comprise a sucession of fill, alluvium and insitu decomposed granitic soils down the bedrock, at some 45m to 60m below ground, therefore, shallow footing is not recommended.	
2.2.3 Foundation Design  No specific requirement.	H piles would be used for the proposed building block, noise barrier and carpark.	
2.2.4 <u>Drainage and Sewerage</u>	As in the Approved Development Parameters.	

# 2. SITE ANALYSIS & EVALUATION

Approved Development Parameters	Proposed Master Layout Plan	Remarks
2.2.5 Water Supply Adequate water supply provisions for the proposed development to be undertaken by WSD.	As in the Approved Development Parameters.	
2.2.6 Electricity, Telephone, Gas Adequate utility supply provisions for the proposed development to be undertaken by utility companies.	As in the Approved Development Parameters.	
2.2.7 Traffic Improvement Traffic improvement has been covered by CED's Supplementary Traffic Impact Assessment.	As in the Approved Development Parameters.	According to the Traffic Impact Assessment by MCAL, the current proposal of PRH/HOS can be accommodated by the planned traffic improvement works recommended in CED's study.
2.2.8 Drainage Reserve Area Drainage reserves of 8.5m alongside the South-western boundary of the site.	As in the Approved Development Parameters.	
2.2.9Site Formation The site is held under Short Term Tenancy which will be terminated before piling works commence on October 2000.	As in the Approved Development Parameters.	Health Department is responsible to take up the works of the clinic portion.

#### 3. ACCOMMODATION AND FACILITIES

Approved Development Parameters	Proposed Master Layout Plan	Remarks
Gross site area: 7,800 m <sup>2</sup> Clinic Site: 2,070 m <sup>2</sup> Domestic Site Area: 5,730 m <sup>2</sup> Net site area: 6,411 m <sup>2</sup>	As approved in SPC paper No. 30/99 dated 11 September 99.	The net site area as shown on left has excluded area of the proposed estate road and non-building area (i.e. the drainage reserve to the south of the Site).
Permissible DR: 5-7  Gross Floor Space Domestic 36,816m <sup>2</sup> Clinic 7,000m <sup>2</sup> Total: 43,816m <sup>2</sup> Development Ratio: =43,816 / 6,411 =6.83  Domestic Plot Ratio: 7.98 Non-Domestic Plot Ratio: 0.13 (refer to plot ratio and development calculation sheets)	Development Ratio (D.R.)  Calculation  Gross Floor Space  NH1 Opt. 6 = 38,253 m <sup>2</sup> (933 m <sup>2</sup> x 41)  Area attached in Wings B & C  = 106 m <sup>2</sup> Total : 38,359m <sup>2</sup> Development Ratio : =38,359/5,730 = 6.7 < 7	Domestic GFA =  *34,625.63 m <sup>2</sup> * refer to BC11/99 dated 15 January 99.  GFA of EMO & Contractor's offices =  501.7 m <sup>2</sup>
3.3 Flat Number and Flat Mix  The proposed public rental housing development is planned to provide a total of 799 flats.	The proposed development provided one standard New Harmony 1 Opt 6. The flat mix is as follows:  Flat 1/2P 2/3P 1B 2B Nos. 159 320 160 160 % 19.9 40.1 20.0 20.0	

PDRC(2) – ISSUE 1 Page 1 of 3

## 3. ACCOMMODATION AND FACILITIES

Approved Development Parameters	Proposed Master Layout Plan	Remarks
3.4 <u>Design Population</u>	The design population for 799 flats is 2,020 persons. (2.53 persons/ unit)	
3.5 Refuse Collection Point 1 for the whole Rental Estate	Proposed to be located at the corner of carpark. (110m <sup>2</sup> IFA).	
3.6 Management Accommodation 3.6.1 Estate Management Office 1 for the whole Rental Estate	Proposed to be located at G/F of Wing C.	As per SHM/D&V's "Standard Provision for Rental Estate" for the project dated 5.5.99.
3.6.2 <u>M.A.C. Office</u> 1 for each block (15 - 20 m <sup>2</sup> IFA)	Proposed to be provided at G/F of Wing B (17.3 m <sup>2</sup> IFA).	Ditto.
3.6.3 Artisan Workshop 1 for the whole Rental Estate, to be detached from the Main EMO (20-40 m <sup>2</sup> IFA)	Proposed to be provided at G/F of Wing B (21.5 m <sup>2</sup> IFA).	Ditto.
3.6.4 Office for Cleansing Contractor 1 for the whole Rental Estate (32.5-46.5 m <sup>2</sup> IFA)	Proposed to be provided at G/F of Wing B (22.2 m <sup>2</sup> IFA)	Ditto.
3.6.5 BW Term Maintenance Contractor Service / Store Room 1 for the whole Rental Estate (70-100 m <sup>2</sup> IFA)	Proposed to be provided at G/F of Wing B (49 m <sup>2</sup> IFA)	Ditto.

PDRC(2) – ISSUE 1 Page 2 of 3

## 3. ACCOMMODATION AND FACILITIES

Approved Development Parameters	Proposed Master Layout Plan	Remarks			
3.6.6 BS Term Maintenance Contractor Service / Store Room 1 for the whole Rental Estate (70-100 m <sup>2</sup> IFA)	Proposed to be provided at G/F attached to Wing B (54.7 m <sup>2</sup> IFA).	Area as shown on the control plan in PDRC Paper No. 28/99 is 58.2m <sup>2</sup> .			
3.7.1 Local Open Space A minimum of 2,560 sq.m. of local open space shall be provided to serve the proposed development.  3.7.2 Recreation Facilities 205 sq.m. Children Playing Area is required.	Local open space provided.				

#### 4. CIRCULATION AND TRANSPORTATION MATTERS

Approved Development Parameters		Proposed Master Layout Plan	Remarks
4.1	Vehicular Access	As in the Approved	
	Main access from Hin Keng Lane	As in the Approved Development Parameters	€
4.2	Pedestrian Access		
	No special requirement	Pedestrian access is provided at these points: at south-east giving access to the adjoining Hin Keng Estate and existing bus stops; at north-west giving access to the nearby KCR station; at north-east giving access to an existing pedestrian subway under Tin Sam Street.	
4.3	Control of Ingress and Egress No special requirement	Guard kiosk, drop gate to be provided at entrance to the estate road; automated carpark control system to be provided later by carpark operator as required.	
4.4	Emergency Vehicular Access (EVA)		
	No special requirement	Domestic block and carpark building shall be accessible with EVA/estate road.	
4.5	Pedestrian Network No special requirement.		

# 4. CIRCULATION AND TRANSPORTATION MATTERS

Approved Development Parameters	Proposed Master Layout Plan	Remarks
4.6 Parking Provision 4.6.1 Carpark Spaces *799 / 16 = 50 nos.  * includes the no. of 1P/2P flat	As in the Approved Development Parameters	Rate of Provision for carpark PRH: 1 per 13-16 flats  Dimension 2.5m (W) x 5m (L) x 2.4m (H)
4.6.2 Motor-cycle Spaces 3 nos.	As in the Approved Development Parameters	5 % of total parking space.
4.6.3 <u>Light Goods Vehicle</u> (LGV) <u>Spaces</u> (799-*159) / 80 = 8 nos. *	Along the site boundary at the South	Rate of provision for LGV: 1 space per 80 flats
* no. of 1P/2P flats	**	TD has no objection to the number of LGV provided.  [PM/2 's memo to TD dated 22 March 00 (ref: HD(PM)55/693/1) refers]
4.6.4 <u>Residential Loading/</u> <u>Unloading</u> 1 no. is required.	As in the Approved Development Parameters	Provision of 1 per domestic block.
4.6.5Bicycle Parking 27 nos. is required.	As in the Approved Development Parameters	Rate of provision for bicycle: 1 space per 30 flats

PDRC(2) – ISSUE 1

Page 2 of 2

# 5. DESIGN CONSIDERATIONS


Approved Development Parameters	Proposed Master Layout Plan	Remarks		
5.1 Block Types, Disposition and Orientation	As per Control Plan except:- i) orientation of block revised ii) RCP is relocated to away from the vehicular and pedestrian entrance.			
5.2 Design of Noise Barrier No special requirement.	The site, with its trees and garden, and its limited area, suggested glass noise barrier would be appropriate. The result is a curtain of glass defines the development, yet maintain a certain degree of transparency.  This transparent membrane adopted a playful form originated from the noise reduction requirement.  The eave-like canopy defines the top-end of the noise barrier to reduce it to a human scale.  The canopy at the roof top of the domestic block is proposed to reflect the canopy of the noise barrier, to unify the Development as a whole and to enhance the individual identity of the Development.	Both Transport Department and Highways Department have no objection to the proposed projection of canopies over street.  [TE(NTE)Div./TD's memo dated 5.4.2000 (ref: NR 182/191-41) and Highways/NT Region 's memo dated 20.3.2000 (ref: HNT 706/ST/14) refers]  Comment from DLO/ST is pending.		


#### **DESIGN CONSIDERATIONS** 5.


Approved Development Parameters	Proposed Master Layout Plan	Remarks		
5.3 Landscape Design No specific requirement.	Curvilinear planters create a leisure atmosphere and contrasting to the rectilinear building block.  Landscaping in the roof garden and pedestrian area is to be designed in safe and secure manner to improve the built environment and visual quality of the Estate.			
5.4 Design for the Disabled No special requirement.	All buildings, open spaces, pedestrian circulation and public transport facilities are designed to cater for the needs of the disabled.			
5.5 Graphics and Signage No specific requirement.	Graphic and signage system to be designed in accordance with the D&S's signage manuals.	Reference: Signage Manual for Public Housing Estates.		


## MASTER LAYOUT DRAWINGS


DRAWING LIST: -		
Drawing No.	Revision	Drawing Title
ST32/SITE/A/PLO-01	P02	SITE LOCATION PLAN
ST32/SITE/A/PLO-02	P03	G/F LAYOUT PLAN
ST32/SITE/A/PLO-03	P02	PODIUM LAYOUT PLAN
ST32/SITE/A/PLO-04	P02	ROOF PLAN
ST32/SITE/A/PLO-05	P02	WEST ELEVATION
ST32/SITE/A/PLO-06	P02	SECTION A-A
ST32/BL1/A/PLO-01	P01	BLOCK 1 – G/F PLAN
ST32/BL1/A/PLO-02	P01	BLOCK 1 – F40 PLAN
ST32/BL1/A/PLO-03	P01	BLOCK 1 – UPPER ROOF PLAN WITH SPRINKLER TANK
SK/A/PLO-01	P02	ELEVATION OF NOISE BARRIER
SK/A/PLO-02	P02	AXONOMETRIC VIEW FROM CHE KUNG MIU ROAD
SK/A/PLO-03	P01	AXONOMETRIC VIEW FROM HIN WO LANE

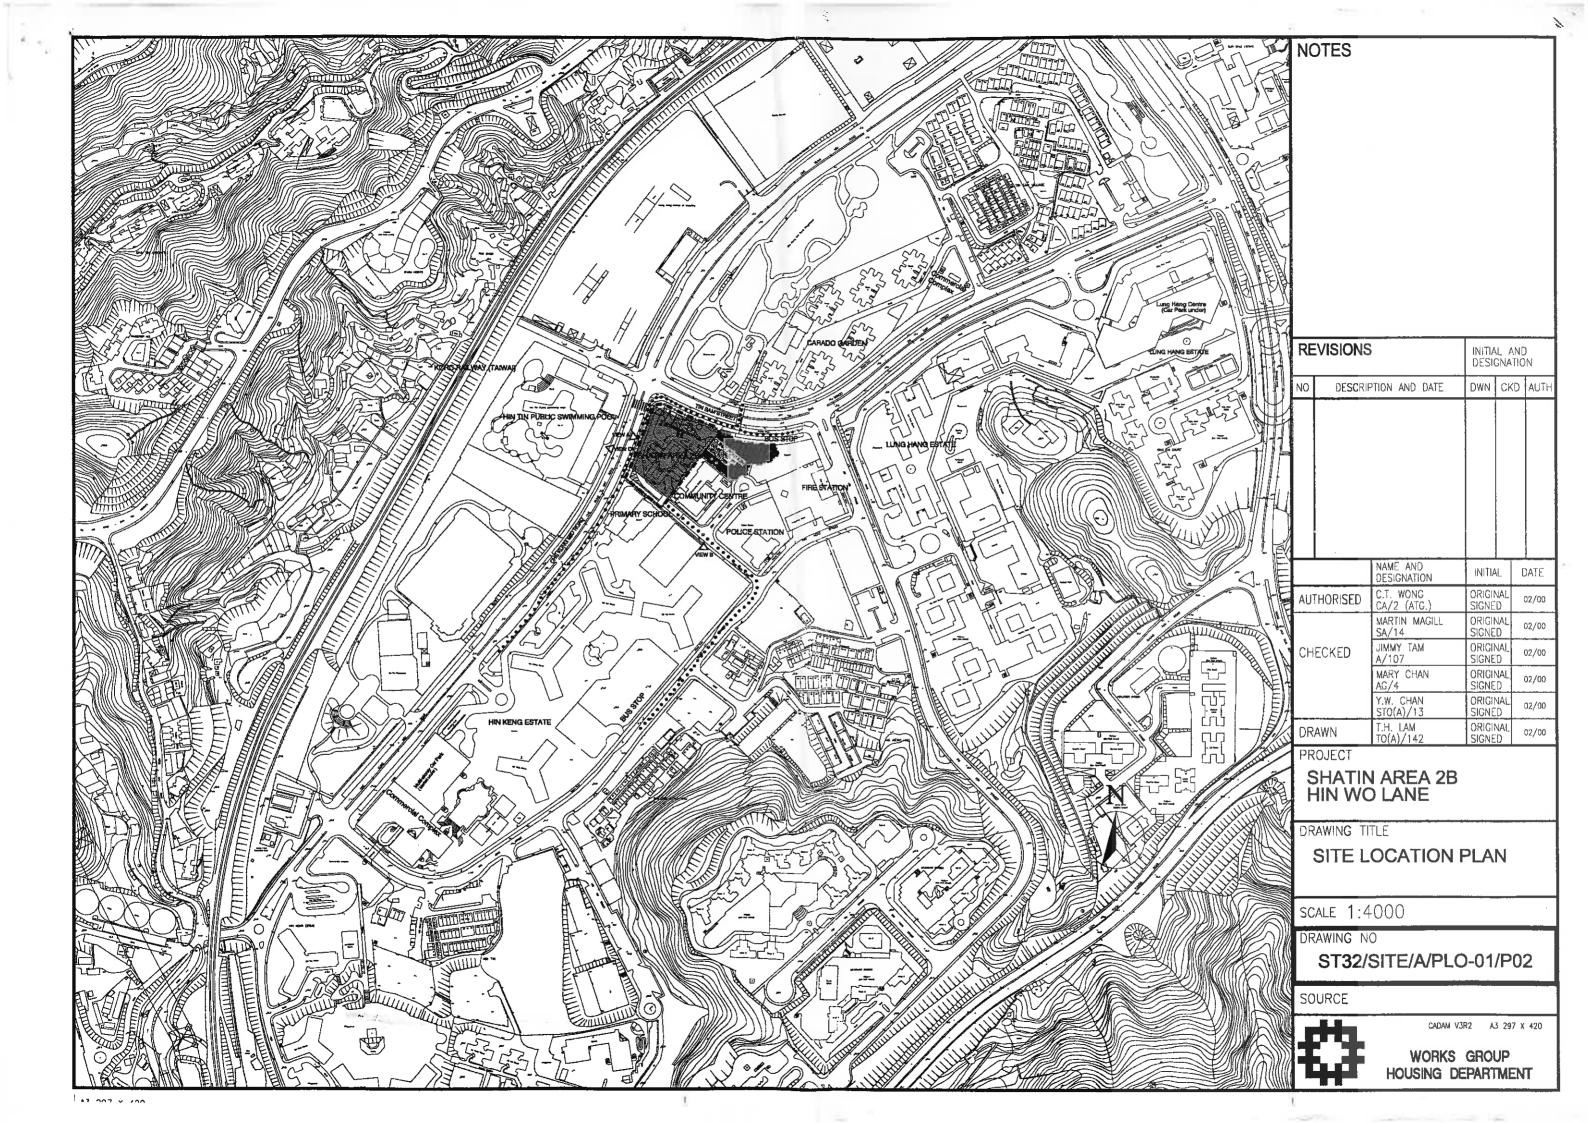

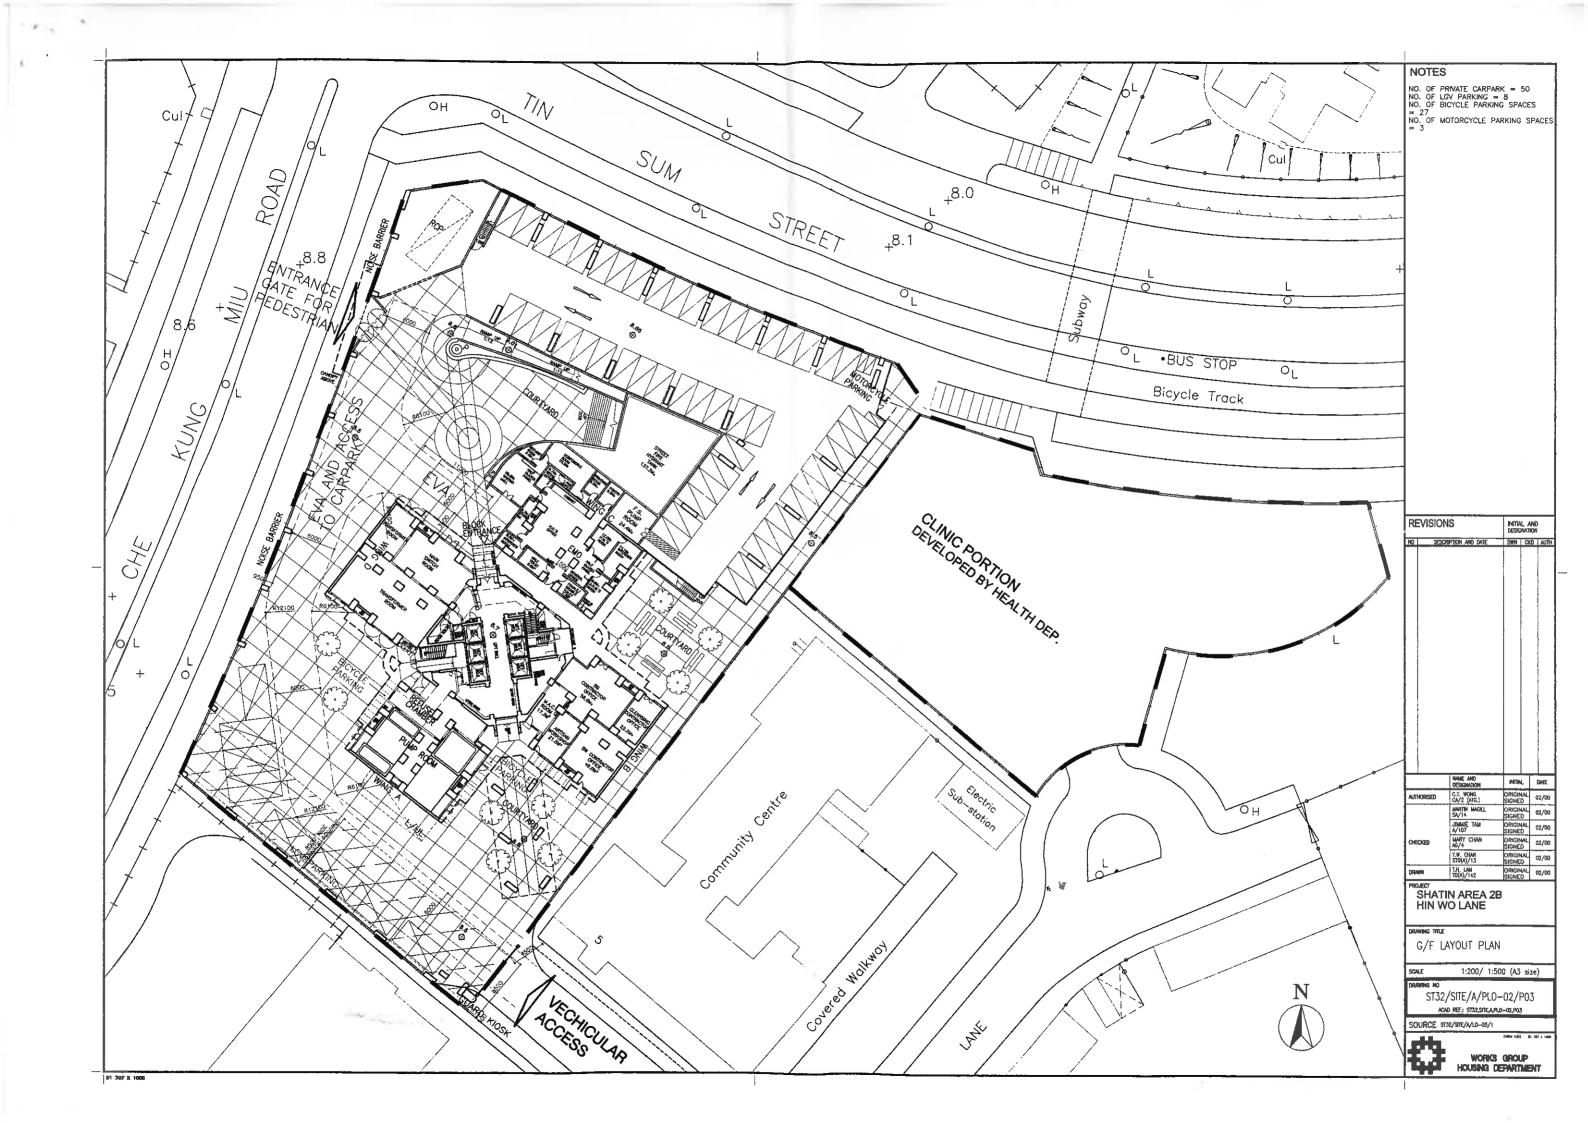

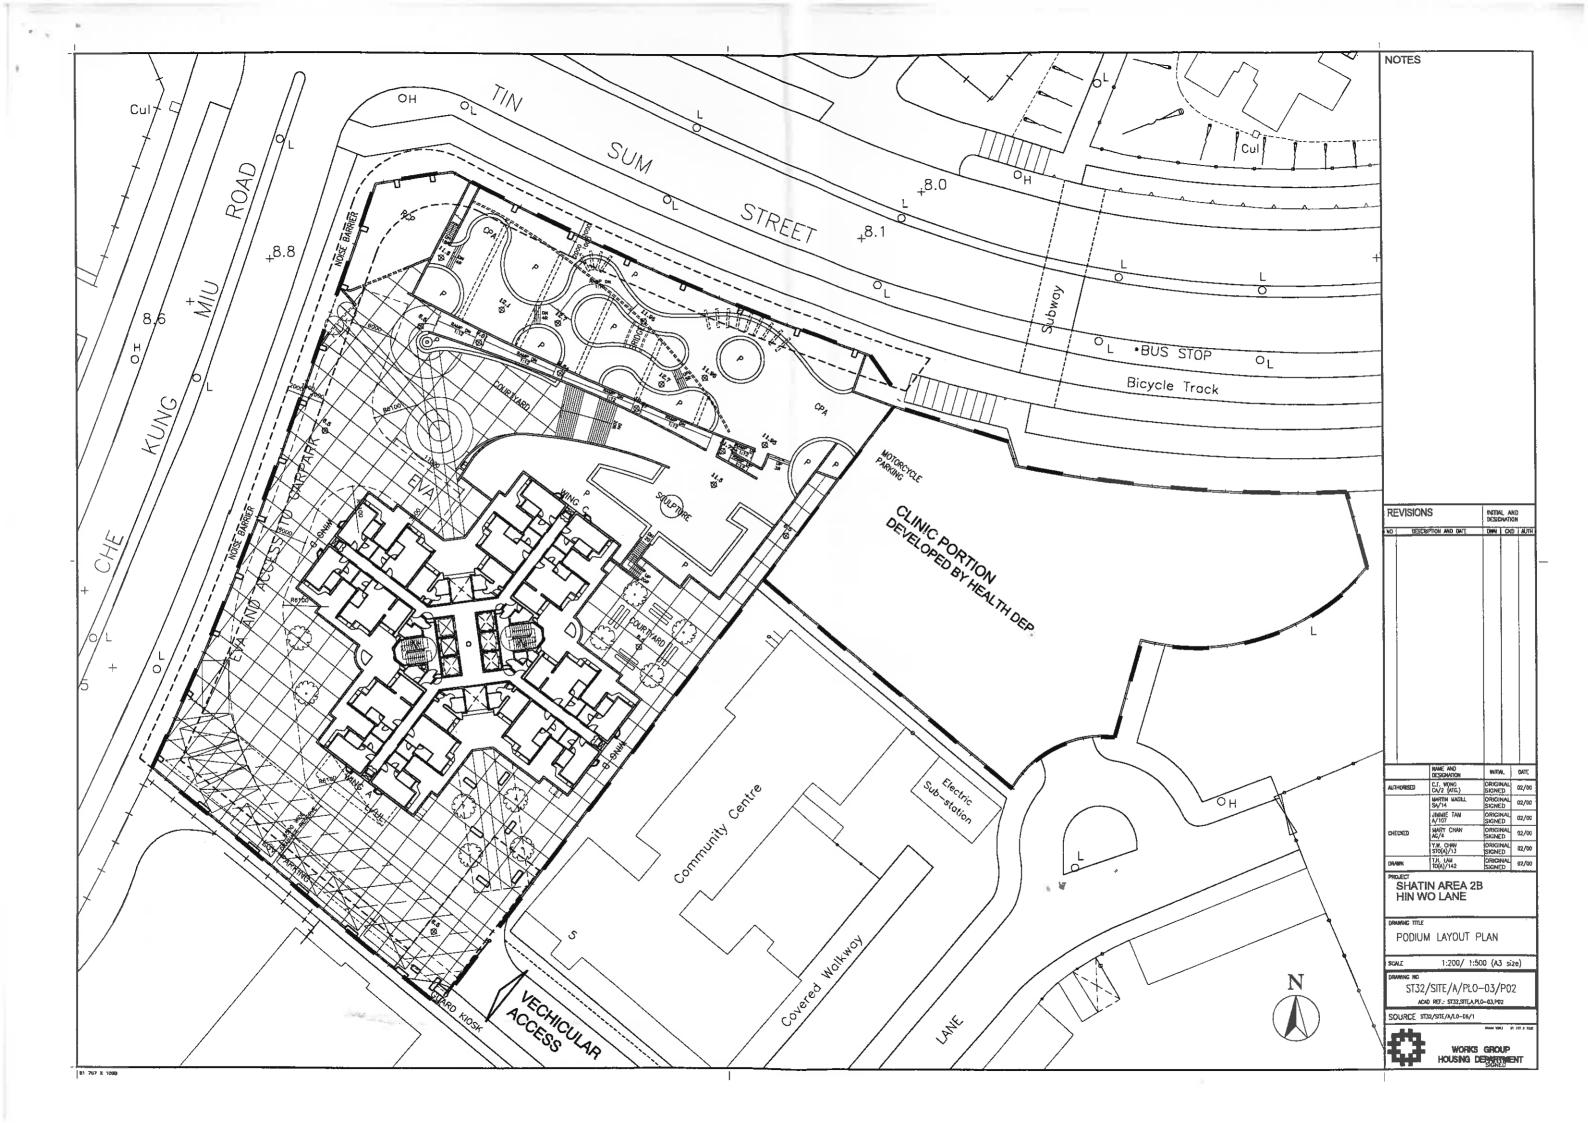

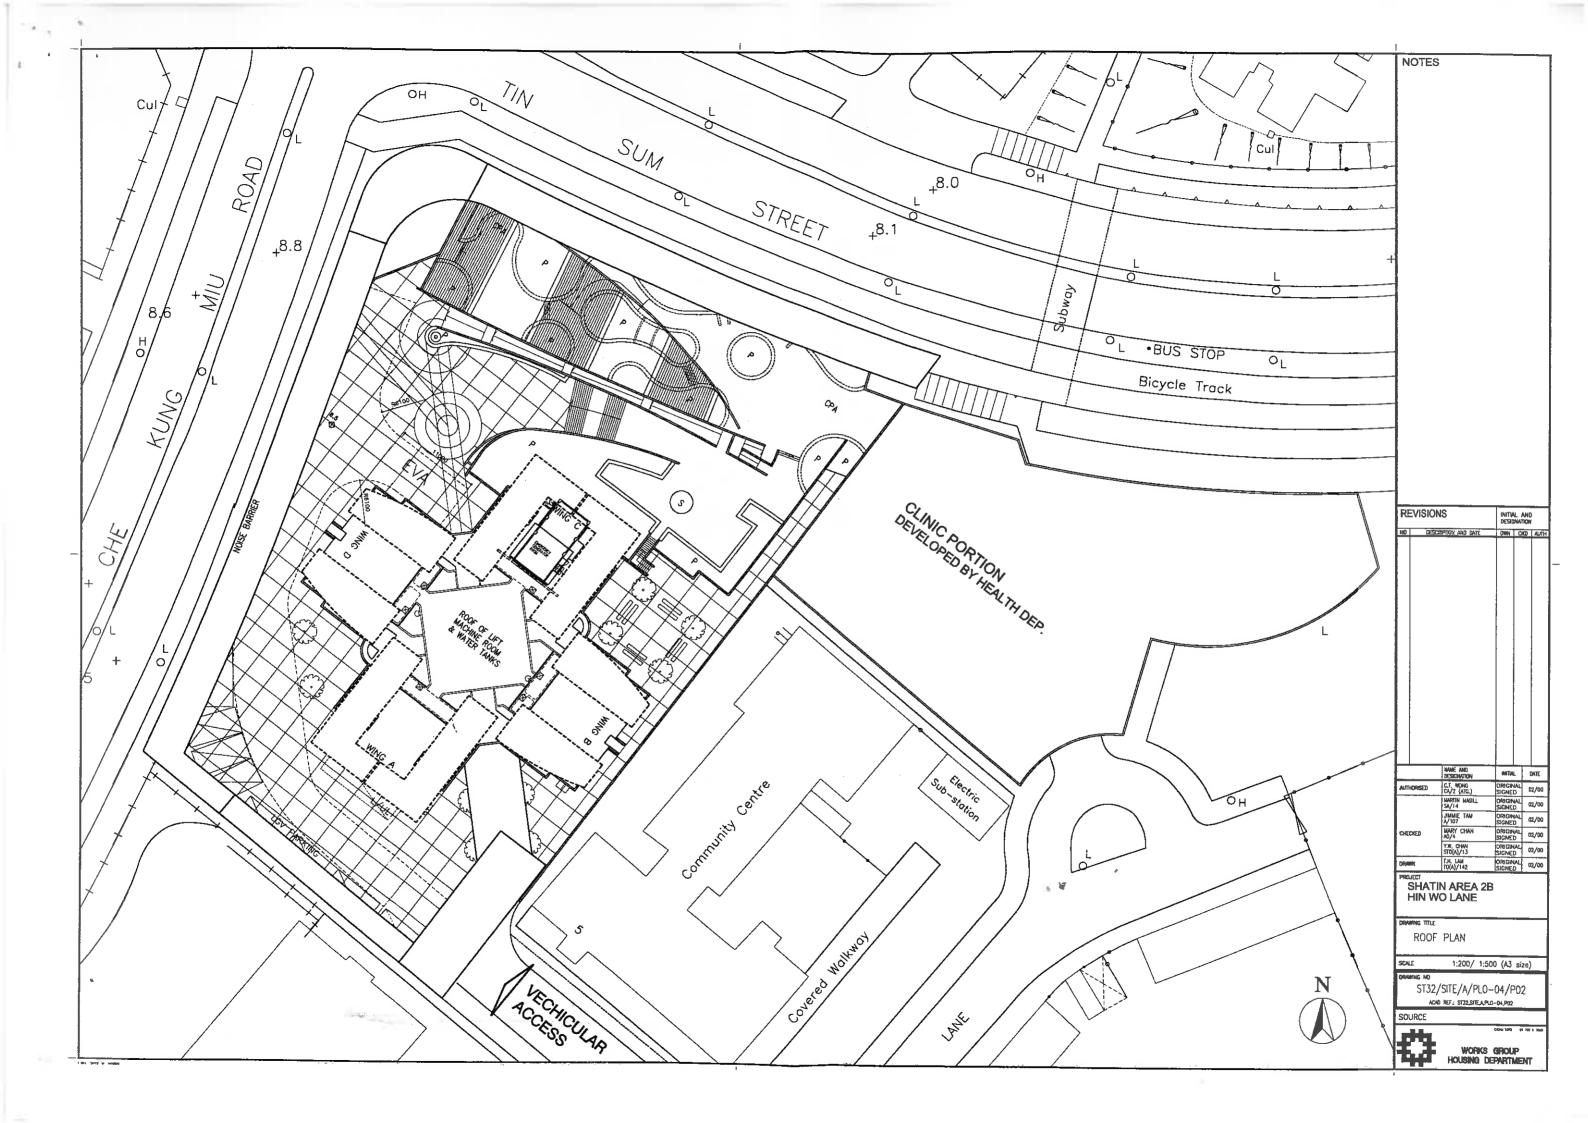

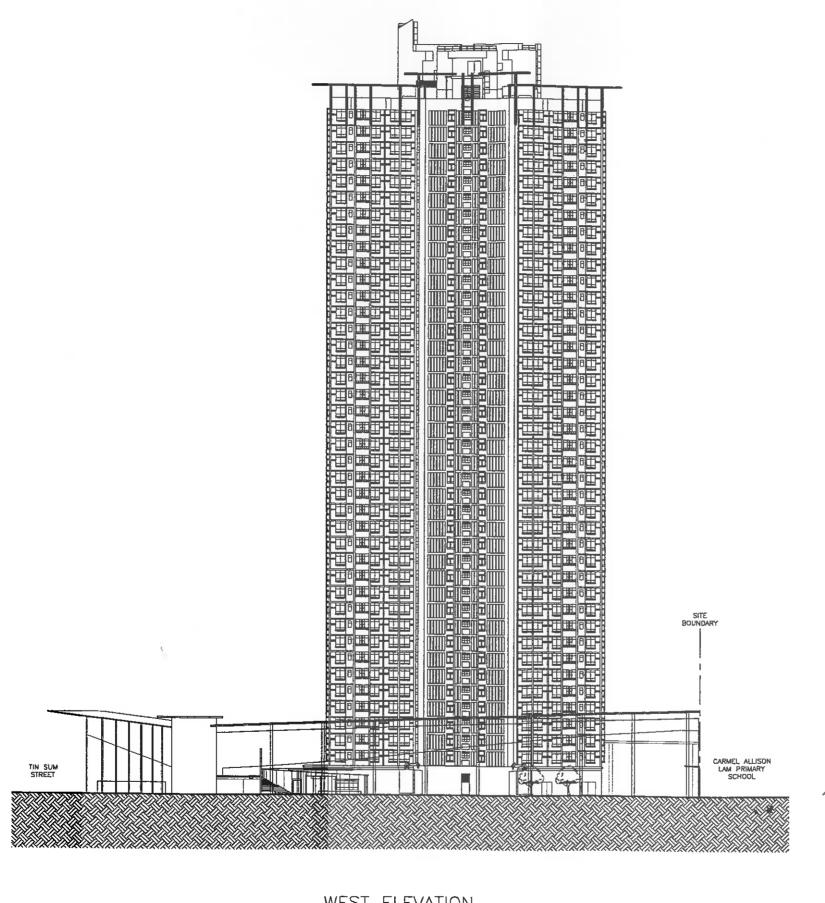

WEST ELEVATION

REVISIONS NO ) CESCRIPTION AND DATE DWN CKD AUT INITIAL DATE CRIGINAL 02/00 SIGNED 02/00 C.T. WONG CA/Z (ATC.) Martin Magili Sa/14 ORIGINAL SIGNED JIMMIE TAM A/107 ORIGINAL 02/00 MARY CHAN ORIGINAL 02/00 SIGNED Y.W. CHAN 5TO(A)/13 ORIGINAL 02/00 SIGNED 02/00 T.H. UAM TO(A)/142 DRIGNAL DZ/00 SHATIN AREA 2B HIN WO LANE DEMONS TITLE WEST ELEVATION

02/00


1:250/ 1:625 (A3 size)

Works Group Housing Department

ST32/SITE/A/PL0-05/P02 ACAD REF.:\$T32,\$TE,A,PLO-05,P02.DWG

SOURCE

NOTES

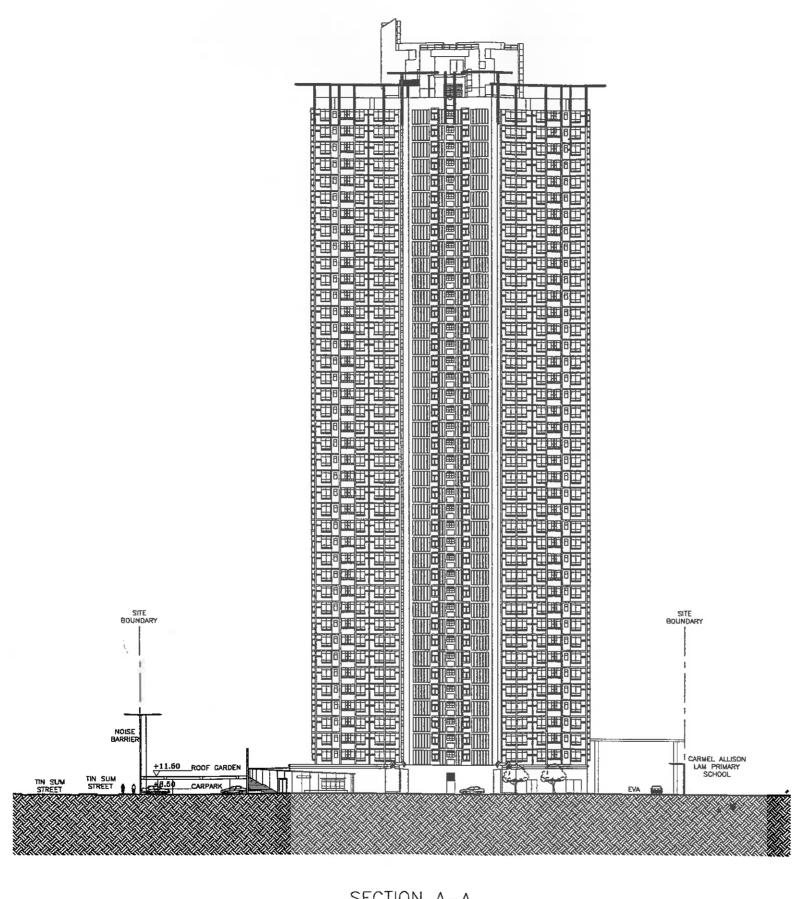

SECTION A-A

REVISIONS MO DESCRIPTION AND DATE C.T. HONG CA/2 (ATC.) BLARTIN BAGILL SA/14 JIMME TAN MARY CHAN T.R. LAM TO(A)/142 HIN WO LANE

DWN CKD AUTH

INTIAL DATE

ORIGINAL SIGNED

ORIGINAL SIGNED

NOTES

ORIGINALI SIGNED ORIGINAL SIGNED SHATIN AREA 2B

DRAWING TITLE SECTION A-A


1:250/ 1:625 (A3 size) SCALE


ST32/SITE/A/PL0-06/P02 ACAD RET.: ST32,SFEA,PLO-06,P02.DWG


SOURCE




WORKS GROUP HOUSING DEPARTMENT

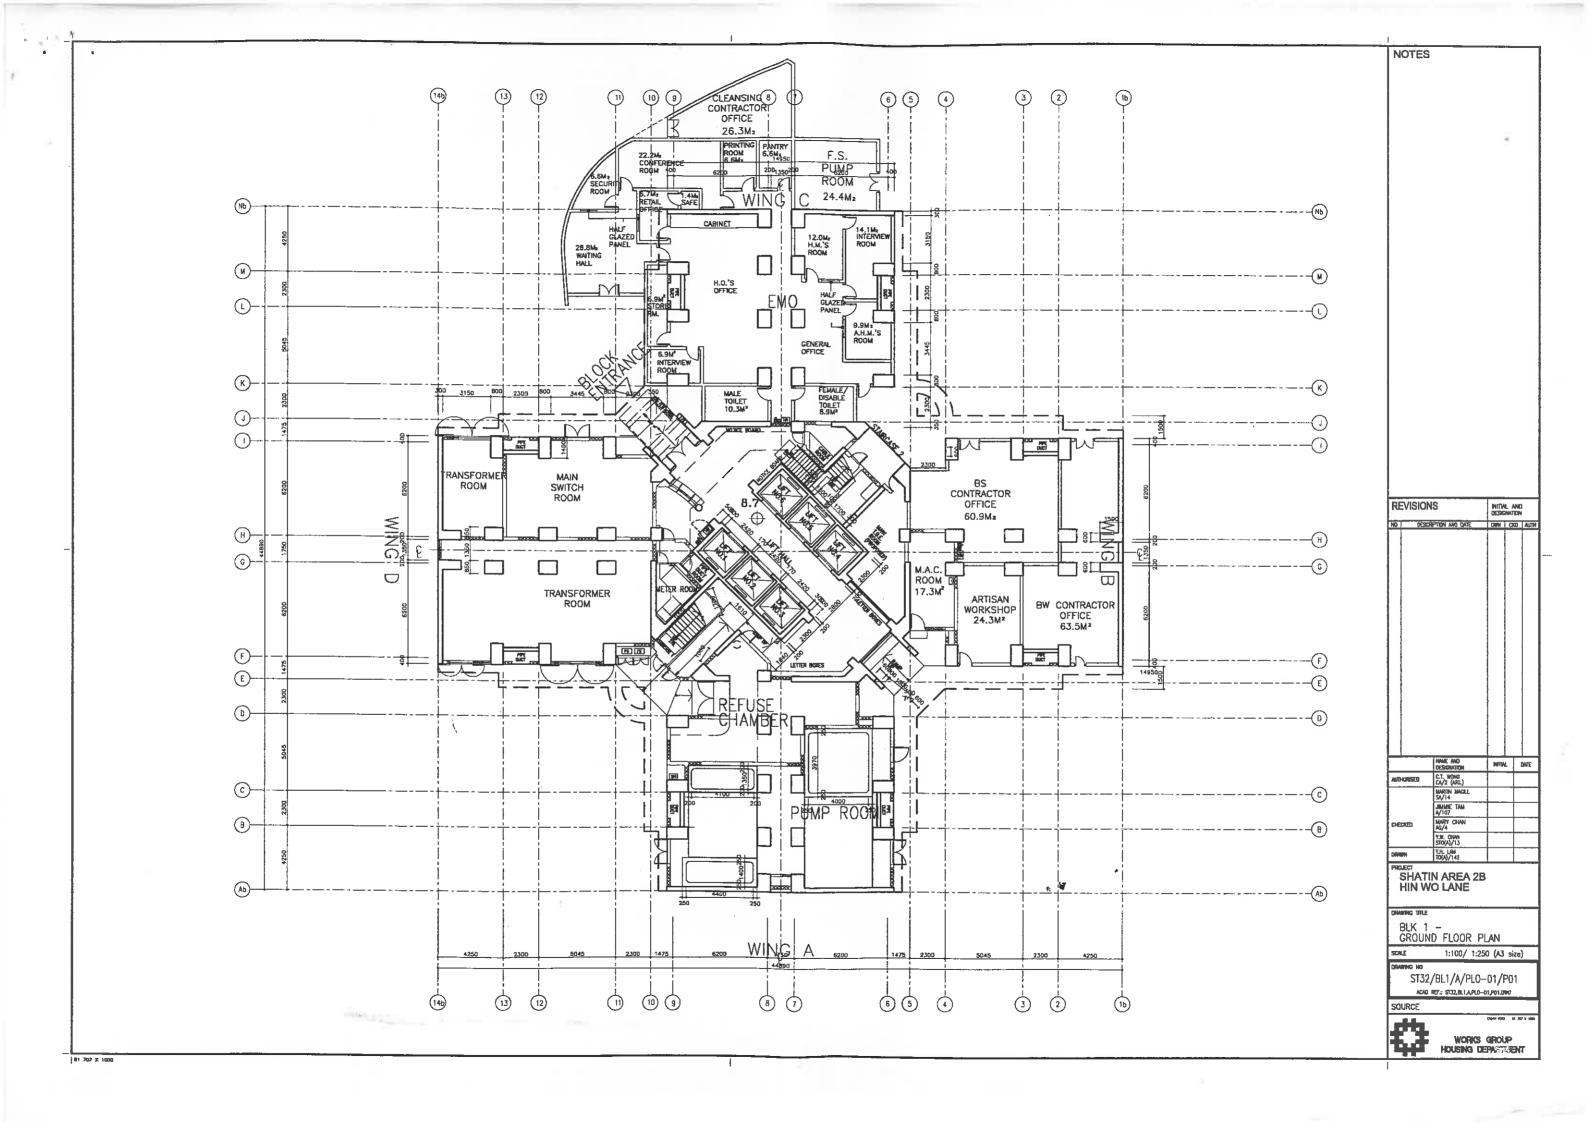

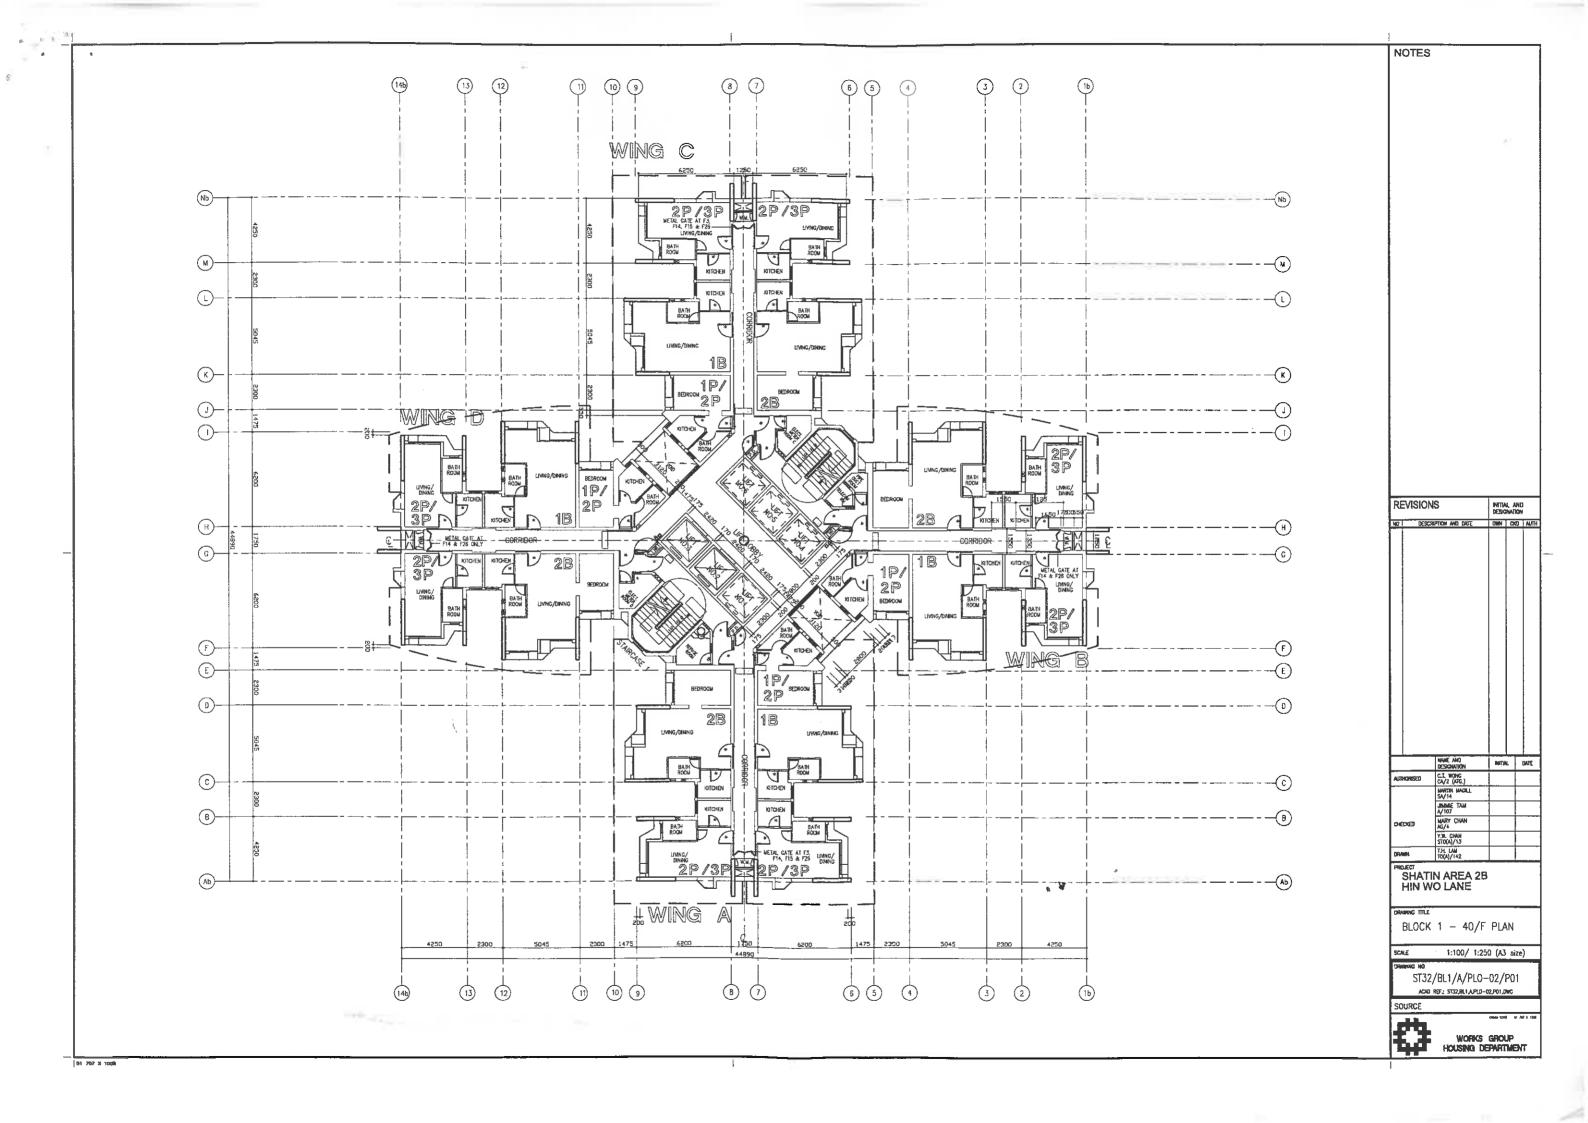


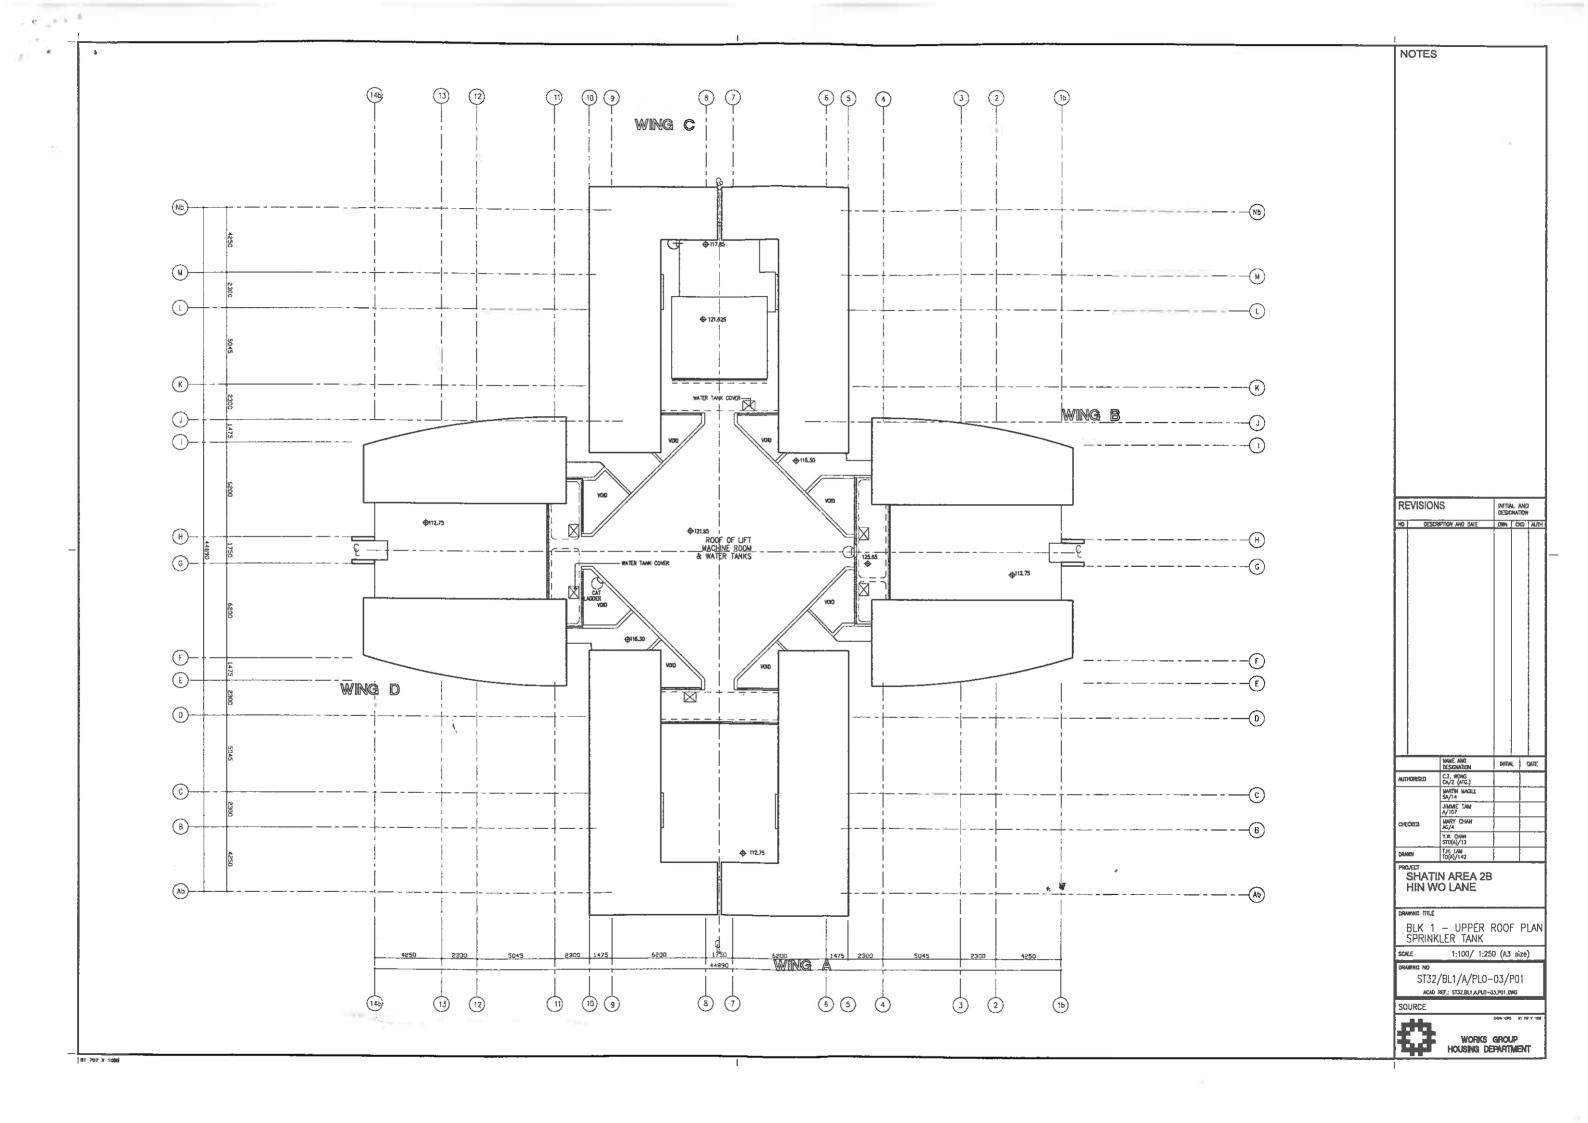

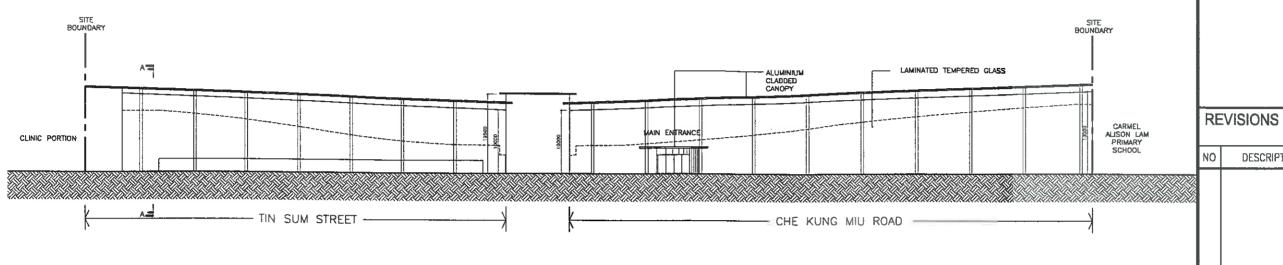

ELEVATION OF NOISE BARRIER

SCALE 1:600

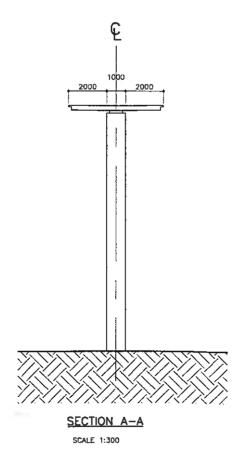

NAME AND DESIGNATION C.T. WONG CA/2 (ATG.) **AUTHORISED** MARTIN MAGILL SA/14 JIMMY TAM A/107 CHECKED MARY CHAN AG/4 Y.W. CHAN STO(A)/13 T.H. LAM TO(A)/142 DRAWN PROJECT SHATIN AREA 2B HIN WO LANE DRAWING TITLE **ELEVATION & SECTION OF** NOISE BARRIER

SCALE AS SHOWN

DESCRIPTION AND DATE

NOTES

CADAM V3R2 A3 297 X 420

SK/A/PLO-01/P02

INITIAL AND DESIGNATION

DWN CKD AUTH

DATE

INITIAL



SOURCE

DRAWING NO

WORKS GROUP HOUSING DEPARTMENT



REVISIONS			INITIAL AND DESIGNATION		
NO	DESCRIPTION AND DATE		DWN	CKD AUTH	
					de file of the fil
		NAME AND DESIGNATION	INIT	VL.	CATE
AUTHORISED		C.T. WONG CA/2 (ATG.)			
CHECKED		MARTIN MAGILL SA/14			
		JIMMY TAM A/107			
		MARY CHAN AG/4			
		Y.W. CHAN STO(A)/13			
DRAWN		T.H. LAM TO(A)/142			

PROJECT

SHATIN AREA 2B HIN WO LANE

DRAWING TITLE

AXONOMETRIC VIEW FROM CHE KUNG MIU ROAD

SCALE N.T.S.

DRAWING NO


SK/A/PLO-02 /PO2

SOURCE

CADAM V3RZ 45 ZE7 K 4EC



WORKS GROUP HOUSING DEPARTMENT

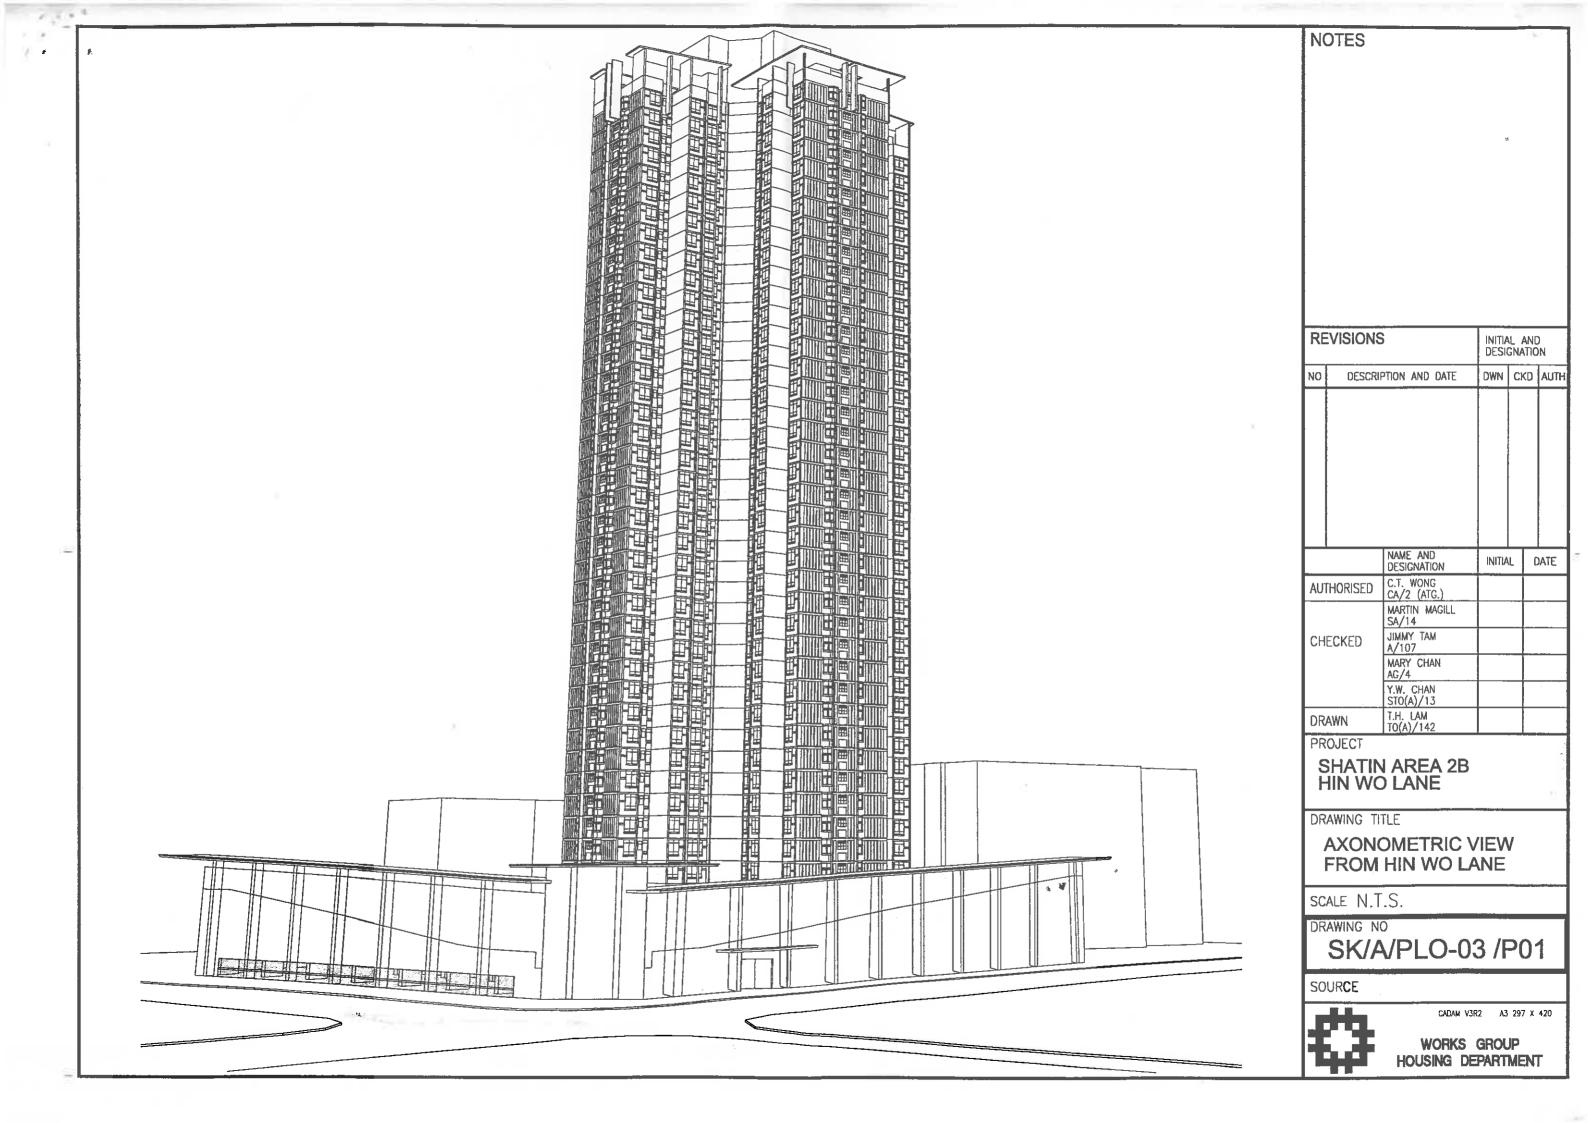

# SHATIN AREA 2B

## ST32NR

		1999	امامام	T. d. d.	2000	( ) e la		Is also lea	2001	·	1-1-1-		2002		_/ 1 !		2003		····		12007	NOTES
	DEVELOPMENT PARAMETERS CONCEPTUAL LAYOUT	· '	:	  -  -		4 5 6 		[10]11]12 	1 2 3	4   5   6     	7 8 9	10 11 12   	1   2   3	4   5   6	7   8   9	10 11 12	1   2   3	4 5 6	7   8   <del>9</del>     	<u> 10  11  12</u>  -  -  -	1 2 3	TENDER AWARD
HWME	STRATEGIC PLANNING COMMITTE		•	SPC 9/99			     			1 1		     							l   	     		PILING CONSTRUCTION  BUILDING CONSTRUCTION
PROGRAMME	MASTER LAYOUT & PROJECT BUDGET		       		▼ P:	200	     	 		1									     	     	~	
SUBMISSION	BUILDING COMMITTEE		 			<b>■</b> BC 27/	4/00	 		] ] ] ]									     	\$ }		
SUBMI	DETAIL DESIGN		] ] ]	     		•	DDRP 6/00	       		 									       	     		REVISIONS INITIAL AND DESCRIPTION AND DESCRIPTION AND DATE DAM CAD AUTH  1. BUILDING CONSTRUCTION STORESTORES AND AG/4 CG1.30 CG1.50
			1     	     	1	     	1 1 1	       		     	.     		i						     	   		
	PILING TENDER		   	 		TI  6/00 ♦	•	TA 19/00		   	! !				) {		i		Î 	;   		
PROGRAMME	PILING CONSTRUCTION		}     	! ! !		     	10/00	777	(10 MC	NTHS)	8/I	<b>)</b> 1	- ')   		     				     	     		NAME AND TRITIAL DATE DESIGNATION TRITIAL DATE AUTHORISED C.T. MONE CAZZ (a.t.)
1	BUILDING TENER		     	!		 	     	   	TI 4/01	<b>\$</b>	◆ TA 7/01		     		     		] ] ]			 		M. NeZILL SA/14 J. H. X. TAM A/107 CHECKED HARY CHARL
CONSTRUCTION	BUILDING CONSTRUCTION							1 1 1 1 1 1 1 1 1 1 1 1 1 1 1 1 1 1 1		8, 1	01		- 1		(30 N	(ONTHS)					2/04	Y. H. CHOL STUCO // 3

4 DEVELOPMENT COST BUDGET

PROJECT : Shatin Area 10 PHASE : - PHDP Code : \_\_\_\_

		COST PORTIONS										1
	PRII	Itos	CC	CP(PC)	WEL.	UN	GN	OCP(LGV)	Cerame 7S	EW	Total	l
									<u> </u>			l
CFA of Cool Portlans (m2)	36,014			1,367	21	509	-	-			37,513	ĺ
											0.015	i i

				<del></del>		<u> </u>			1	L	٠ ا	37,513	l
					·								
COST ITEMS		1											Fluctuation
A. Sile Development & Construction Cost Number 44 Lane 1999							Estimated Co	st la 5,000					Provolega
													- Troughtany
(Excluding Fluctuations & Tender Price Infiction)		ł	l	i	1		l		l	l	1	i	
1.0 Site Development Caste		1	l	1	1	İ	l		l	l	1		ŀ
1.1 Site Permution Contract		1	l	1	1		l		l	i	1		Ī
1.2 Demoilifon Contract		· ·									Ι.	l .	
		١ ٠		-	1 -	-			l .	l :	1 .		' '
1.0 Camicutiles Cests		1	1	l .	1	ł	1	l	1	1	1 '		
2.1 Foundation Contract		1	1	l .	1	1	1		ļ	1	l .	1	l
2.11 Building Foundations		1	1	Į.	1	1	l		ł	ł		l	i
		13,922	-		1,062	13	280	_ ا		ì			
2.12 External Works for Specific Businesses		5,648	-		216	4	10		Ι .		١ ٠	20,277	
BB 15.1141		1	l	1		1	"	١.	١ .		1 -	5,982	-
2 2 Building Contract		1	!	1	1	Į	l		l	l	1		
2 21. Hullding Works (excl. building services)		156,226		Ι.	2,474	129		ŀ	l	l	1		1
2.23 Building Services		33,929	l .		277		2,339	٠.	194		١ .	161,882	7,661
2 23 Transfer Structures		1	1 .	١.	411	10	214					34,430	,,
2 24 Public Transpart Interchange		1 .	1		,	1.5			٠ .				Ι.
2.25 External Works for community strated elements			Ι .				٠ ا		- ا			l .	
2.26 External Works for Specific Businesses		1	· ·	1 .	1 -	-		-		١.	1 .	1 .	-
2.27 Automated Refuse Collection System		38,99			1,481	27	550 ·		_	Ι,	Ι.	41,049	
					<b>!</b> • .	-		١.	Ι.	Ι.		11,049	2,218
2.3 Other Separate Contracts (Incl. Softtlandscape)		834		l .	32	1	12	ŀ		l '	_		-
Cool Buriget At June 1999 Price Level					<del>                                     </del>	<del></del>	- '-	<u> </u> -	<u> </u>	<u> </u>		883	•
	(A)	254,594	٠.		5,542	<b>L24</b>	3,995		194		١.	264,509	
B. Cial Luimaie Projected To				<del> </del>	<del></del>	<del> </del>		<u> </u>			L	204,349	9,679
Proposed Buies of Tenders   Cost in liem (A) phu Cost a fry (m).	(v) ac (z) !	4			1			Į.					
		l l			Ι,	l		ŀ		l	ŀ		
		ſ	l					İ	ŀ	l	ĺ	Į .	
1 a au a		ł	ľ			ŀ		l	ŀ	l	1		
1.0 Site Development Coats	Total (S'ht)	į .					ŀ	!		l	ľ	1	
J.1 Site Formation Contract	1	1 -	Ι.	Ι.	Ι.		1	į.		ı	ł		
1.2 Demolition Contract		1 .	١.	1 .	1	-	•		•	٠ .	-	-	
		ì	1	1 -	١ ٠	-			-	-			_
1.6 Cynnirucijen Cenig		Į .	l			ľ	l .			l	i	ľ	
2.1 Foundation Contract		1		ŀ	1	Į.	1	!	l	l		·	
2 11 Building Faundations			l		1			l	l	l	1		
2.12 External Works for Specific Dusinesses		19,639			1,102	13	291	i -	l .	Ι.		21,045	
The state of the s		5,904		-	224	1 4	63				1 -		•
2.2 Building Contract			ł				1	i	i I	•		6,215	-
2.2) Building Works (exc), building services)			!								1.7		
	1.9	166,766		l -	2,640	138	3.051	ŀ			-		
2.22 Building Services		36,203		١.	296	1)	228	•	207			172,742	1,175
2.23 Transfer Sinuclures	14		1 .	1 .	*."	l "	228	•			-	36,740	-
2.24 Public Transport Interchange	-	) . 1		1 .					1 •				_
2.25 External Works for community shared elements		l	]		١ .		•	•			-	1 .	
2.26 External Works for Specific Businesses	76 <u>1</u>	41,607	١ .			•		- 1				1 . 1	
2.27 Automated Refuse Collection System	•			٠.	1,580	29	587		1 -			43,803	
	•	•	,		١.	-	-				1 .	73,003	2,367
2.3 Other Separate Contracts (Incl. Softflandscape)	3	894		١.	34		1		1	i '	Ι.		•
Cost Budget To Proposed Dates Of Tenders			<u> </u>		<del> </del>	<del>                                     </del>	13		-		<u>_</u>	942	
	(B)	270,95\$			5,876	196	4,253	۱.	207			201.007	
				<del></del>	4	<u> </u>		Ī.	3			281,487	10,542

Types af Contract Ske Formation	Tender in Dates	Adjustment for months after June 1999
Demolition	35	Months x #% / (2 =(v)
Foundation	2.8	- Months x # % / 12 = (*)
Duilding ( for inflation adjustment, "External Warks", "Others", etc.,	7/2000	13 Months x 3.5 % / 12 = 0.037917 (y)
Tender-in Dates to be taken the same as "fluiding"}		
	3/2001	23 Months v 1 5 % / 12 - 0 0 0 70 0 0 4 4

For the basis, exclusions and notes of this Cost Budget, please rafer to information shown on Page 2.

### SUMMARY OF SITE DEVELOPMENT & CONSTRUCTION COST BUDGET NO. 4 (cont'd)

PROJECT : Shatla Area 2B PHA	SE: - PHDP Code:					
	- 55					
I and the Coal Boothers						
Legend for Cost Portlans; PRH - Public Rental Housing		Cn	0			
ilOS - Home Ownership Scheme		CP WEL	Carpark		UN 🖹	Unallocable
CC - Commercial (Shopping) Centre		GN		: & Community Facilities ment Non-reimbursable	TS EW	Transfer Strue External Wor
					,,,,,,,,,,,,,,,,,,,,,,,,,,,,,,,,,,,,,,,	Exicting William
20.0						
Noise :	and adjusted the sender rate interior as an in- in dear of					
	and adjusted for tender price inflation to tender in dates of co osts are in accordance with the existing cost apportionment g					
	and are in accordance with the existing cost apportunting it and and Cost Yardstick a shall be highlighted.	nidelitics set out 10 teléA:	IBI DCMBI.			
	connections, etc. shall be grouped under Other Separate Con	niracis.				
(5) The fluctuation provisions shall be we	rked out based on the formula as shown on the Guidance No	tes for Standard Cost Ya	rdsticks.			
				12		
<u>Inclusione :</u>						
(1)						
Exclusions :						
	ssional services & overheads, consultant fees, etc.					
	vironmental studies, land surveying studies, site potential and	d other empireering studi	es site investigation	ng geolochnical		
advisory services, construction materi	al test, piling test carried out by direct testing contractor, etc.	a amer engineering stade	cs, and investigation	m, geotecnnical		
Assumbliens :						
	tings are allowed for external areas including Podium Garder					
		<b>!!-</b>				
Basis of the Budget :						
(1) Project information included in Memo	wendom for the Strategic Planning Committee. EF001 issued on 9th February 2000 Letter ref. B241/29.					
(2) Drawings issued on 16 February 2000	under cover of AG/4's letter ref. IID(AR)55/693/1.			ī		
(3) SE/69's memo ref. HD(SE2)55/693/1.						
Prepared by :	Daniel Tsol	(PQS's Name)		Bridgewater & Coulton Ltd.	(Name of Consultant F	Norma.
			<del></del>			umj
Date 1	2nd March 2000					
		•				

Page 2 of 9

Construction Cost Budget No. 4 (Domestic Blocks: Public Rental Housing Portion)

Project: Shatin Area 2B Phase - (PHDP Code: \_\_\_\_)

		Cost p	er Flat	
Cost at June 1999 Price Level	No. of Flats	Foundation (Incl Caps)	Building (Excl Caps)	TOTAL
1.0 <u>Standard Blocks</u>				
(a) New Harmony Block (Type 1 Option 6 , Block No. 1 , 41 Storeys)				
- 1 B Flat - 2 B Flat - 1P/2P Flat - 2P/3P Flat	160 160 159 320 799	21,900 28,780 12,810 16,490	258,660 339,910 151,240 194,750	280,560 368,690 164,050 211,240
Cost per Flat x Flat No. = Sub-Total (A) (Total CFA = 36,546 m2)		15,422		197,560 (\$ 5,406 /m2 CFA (\$ 247,259 per fla
<ul> <li>2.0 Adjustments to Item 1.0 Above</li> <li>(a) Adjust for foundation to domestic block based on prelimina</li> <li>(b) Ddt. Basic carcase of ancillary/welfare facilities in domestic</li> <li>= 532 m2 )</li> <li>(c) Add allowance for single block project</li> <li>(d) Add for provision of street hydrant tank and pump room</li> </ul>	ry design : block	3,644 -293 - - 149	-1,570 9,028 559	3,644 -1,863 9,028 708
Sub-Total (B)  (Total CFA = 36,014 m2)		3,500		11,517 (\$ 320/m2-CFA) (\$ 14,414 per flat) % over that calculated in Standard Yardsticks
3.0 Non-standard Domestic Blocks				
Cost per Flat x Flat No. = Sub-Total (C) (Total CFA = m2)		-		- (\$ - /m2 CFA (\$ - per flat
Total Cost of Domestic Block - Public Rental Housing Portion at June 1999 Price Level = (A) + (B) + (C) (excluding Provisions for Contract Fluctuations)		18,922	190,155	209,077 (\$ 5,805 /m2 CFA) (\$ 261,673 per flat)

Construction Cost Budget No. 4 (Welfare Portion)

Project: Shatin Area 2B Phase - (PHDP Code: \_\_\_\_)

I			Estimat	ed Cost		
1	Cost at June 1999 Price Level	CFA	Foundation	Building	TOTAL	
Л		(m2)	(Incl	(Excl	1	
			Caps)	Caps)		
ŀ			<	\$'000	>	
1	in Domestic Block ) (G/F or Upper Floors)					
(	a) Welfare facilities (no fitting out included)	23	11	68	79	
	b) Fitting Out for Welfare Facilities  (Total area to be fitted out = 23 m2 GFA)		-	64	64	
2	.0 Other Adjustments for Item 1.0 Above	12				
(2	Adjust for Foundation to domestic block based on preliminary design		2	-	2	
(t	Add allowance for single block project			7	7	
	Total Cost of Welfare Portion at June 1999 Price Level = Total of Items in 1.0 to 2.0 (excluding Provisions for Contract Fluctuations)		13	139	152 (\$ 6,609/m2 CFA)	
		- 1				

#### Remarks

1. Welfare Portion includes the following:

MAC 23

23 m2 CFA

... Construction Cost Budget No. \_\_\_\_4\_\_\_ ( Unallocable Portion)

Project: Shatin Area 2B Phase - (PHDP Code: \_\_\_\_)

		Estimate	d Cost	
Cost at June 1999 Price Level	CFA	Foundation	Building	TOTAL
	(m2)	(Incl	(Excl	
		Caps)	Caps)	
		<	S'000	>
1.0 Ancillary Facilities in Domestic Block) (G/F or Upper Floors)				
(a) Ancillary facilities (no fitting out included)	509	229	1,502	1,731
(b) Fitting Out for Ancillary Facilities (Total area to be fitted out = 509 m2 GFA)		-	1,425	1,425
2.0 Other Adjustments for Item 1.0 Above	2		x	
(a) Adjust for Foundation to domestic block based on preliminary design	•	51	-	51
(b) Add allowance for single block project		-	146	146
Total Cost of Unallocable Portion at June 1999 - Price Level = Total of Items in 1.0 to 2.0		280	3,073	3,353
(excluding Provisions for Contract Fluctuations)				(\$ 6,587/m2 CFA)

### Remarks

1. Unallocable Portion includes the following:

	m2 CFA
Estate Management Office	303
Artisan Workshop	24
BS & BW Contractor Office	139
Cleansing Contractor Office	43
12	509

...Construction Cost Budget No. \_\_4\_ (Carpark Portion)

Project: Shatin Area 2B Phase - (PHDP Code: \_\_\_\_)

		Estimate	d Cost	
Cost at June99 Price Level	Space	Foundation	Building	TOTAL
	(No.)	(Incl	(Excl	Ì
		Caps)	Caps)	
1.0 Freestanding Carpark Building based on Actual Desi	gn	<	<u> </u>	>
(a) Carpark Portion - Private (27.34 m2 CFA per space)	50	2,125	4,949	7,074
(b) Building Services	:	₽	553	553
(c) Ddt for construction cost apportioned to Roof Garden of External Works		-1,063	-2,751	-3,814
		<	\$'000	>
Sub-total (A) :- (excluding Provisions for Contract Fluctual	tions)	1,062	2,751	3,813
(0.00.00.00.00.00.00.00.00.00.00.00.00.0	,			(\$ 2,789/m2 CFA)
(Total CFA based on Actual Design = 1,367 m2			i	(\$ 76,260 / space)
& Average CFA per carparking space = 27.34 m2)		i	2	
			45.88 %	under that caiculated
	[	11	based o	on Standard Yardsticks

2.0 <u>Difference between Actual Design (item 1.0 above)</u> and Cost Yardsticks due to the following :-	Foundation (Incl Caps)	Building (Excl Caps)	TOTAL
	<	\$'000	
(a) Ddt for adjustment to efficiency ratio of car space	-	-181	-181
(b) Add for adjustment on cost of foundation based on preliminary	499	-	499
design			
(c) Add allowance for single block project	-	263	263
(d) Ddt for construction costs apportioned to Roof Garden of	-1,063	-2,751	-3,814
External Works			

#### Remarks

<sup>1.</sup> To be in line with the SPC paper, 50% of construction costs of carpark was apportioned to Roof Garden of External Works.

. Construction Cost Budget No. \_\_4\_ (Open Parking Spaces in External Work)

Project: Shatin Area 2B Phase - (PHDP Code:\_\_\_\_)

		Estimate	d Cost	
Cost at June99 Price Level	Space	Foundation	Building	TOTAL
	(No.)	(Incl	(Excl	
	ļ	Caps)	Caps)	
			GIODO	
1.0 Open Parking Spaces in External Areas Based on Act	mai Design	<	\$'000 <del></del>	>
(a) Light Goods Vehicle Parking at Open Area	8	NEI	194	194
	1,21)			
				:
				•
		<	S'000	>
Sub-total (A) :-		-	194	194
(excluding Provisions for Contract Fluctua	tions)	-		
1		9		(\$ 990/m2 CFA)
(Total CFA based on Actual Design = 196 m2			(\$ 24,250 / space)	
& Average CFA per carparking space = 24.5 m2)		i i	ŕ	
				1

Construction Cost Budget No	_4	_ (External Works - Commonly Shared Across Phases of the
	]	Development and Amongst Various HA Busiesses)

Project :	Shatin Area 2B	Phase	- (PHDP C	Code :)
Total GEA =	5,730 m2; Tota	CFA	37,913	m2; Total LAA =

		Estimat	T	
Cost at June 1999 Price Level	Foundation	Building	TOTAL	
		(Incl	(Excl	
		Caps)	Caps)	1
		<b></b>	\$,000.00	
1_0	External Works based on Actual Design (excl. Contract Price		1	1
	Fluctuation)			
		Į	İ	ì
(a)	Hard Landscape Works (Amenities)	<u>-</u>	9,614	9,614
<b>(b)</b>	- · · · · · · · · · · · · · · · · · · ·	12	4,212	4,212
				_
$\Box$				
	Sub-total (A)	-	13,826	13,826
		ì		(\$ 365 /m2 CFA)
				(\$ 2,413 /m2 GEA
2.0	Special External Works based on Actual Design (excl. Contract Price F	1 ` luctuation)	3,000.00	<b>1</b>
	PARTIE PARTIE VILLE PROPERTY OF THE PROPERTY O	1		
(a)	Footbridges/staircases/ramps	-	197	197
	Noise barrier	4,925	14,965	19,890
	Aluminium Canopy		6,521	6,521
(d)		<u> </u>	2,789	2,789
	Add for partial construction costs of carpark apportioned to Roof	1,063	2,751	3,814
	Garden of External Works	=	_,	
		~ .		
	Sub-total (B)	5,988	27,223	33,211
				(\$ 876 /m2 CFA)
				(\$ 5,796 /m2 GEA)
				2.
	Total Cost of Commonly Shared External Works at June 1999			
	Price Level $\approx (A) + (B)$	5,988	41,049	47,037
	(excluding Provisions for Contract Fluctuations)			(\$ 1,241/m2 CFA)
		l i		(\$ 8,209 /m2 GEA)
				<u> </u>
	* *			
	Cost of Automated Refuse Collection System at June	-	• 11	-
	Price Level			
	(excluding Provisions for Contract Fluctuations)			(S/m2 CFA)
				(\$/m2 GEA)
				1

	Estimated Cost		
Cost at June 1999 Price Level	Soft Landscape	Fees & Others	TOTAL
Cost of Other Separate Contracts (incl. Softlandscaping Work) at June 1999 Price Level (excluding Provisions for Contract Fluctuations)	418	465	883 <u>†</u> (\$ 23 /m2/CF/ (\$ 154 /m2 GE

### Remarks

- 1. To be in line with SPC paper, 50% construction costs of carpark was apportioned to Roof Garden of External Works.
- 2. Allowance has been made for drainage diversion works to be carried out by separate contracts.

Construction Cost Budget No. 4 (External Works - Charged to Specific HA Businesses)

Project:

Shatin Area 2B Phase - (PHDP Code: \_\_\_\_)

Cost at June 1999 Price Level	6 3	9,614 4,212 883
1.0 External Works based on Actual Design (excl. Contract Fluctuation)  (a) Hard Landscape Works (Amenities)  (b) Underground Drainage  9,132 347 12 4,001 152 56	3	4,212
Eluctration	3	4,212
(b) Underground Drainage 4,001 152 56	3	4,212
b) Olideigionia Blanego	1 -	
(c) Soft Landscape & others		685
		1
		1
		ļ
Sub-total (A) 13,971 531 197	10	14,709
Sub-total (A) 13,571 331 127	10	14,702
2.0 Special External Works based on Actual Design (excl.	1	
Contract Fluctuation)	Çi.	
(a) Footbridges/staircases/ramps 187 - 7 2	1	197
(b) Noise barrier - Foundation costs 4,678 - 178 66	3	4,925
(c) Noise barrier 14,215 540 201	9	14,965
(d) Aluminium Canopy 6,194 235 88 (e) Shoring and alignment for drainage reserve 2,649 101 37	4 2	6,521 2,789
(e) Shoring and alignment for drainage reserve 2,649 101 37 (f) Add for partial construction costs of carpark - Foundation costs 1,010 - 38 14	1	1,063
(g) Add for partial construction costs of carpark 2,613 - 99 37	2	2,751
— <b>*</b> (4)		
Sub-total (B) 31,546 1,198 445	22	33,211
Sub-total (B) 31,546 - 1,198 445	22	22,411
<		
Total Cost of External Works Charged to Specified HA		
Businesses at June 1999 Price Level 45,517 1,729 642	32	47,920
(excluding Provisions for Contract Fluctuations)		